

## **GENERAL NOTES** ABBREVIATIONS: SHEET SCHEDULE: SHEET SHEET ISSUE THESE DOCUMENTS ARE THE PROPERTY OF THE DESIGNER AND SHEET NAME Above Finish Floor MISC. A.F.F. NUMBER DATE SHALL NOT BE COPIED, DUPLICATED, ALTERED, MODIFIED OR Miscellaneous м Microllam REVISED IN ANY WAY WITHOUT THE EXPRESSED WRITTEN BOT. B.R.I MECH Blda Restriction Li PROPICNY APPROVAL OF THE DESIGNER. GENERAL NOTES CONTRACTOR SHALL VERIFY ALL CONDITIONS AND DIMENSIONS Not Applicable N/A CLE Change in Finish ABBREVIATIONS Not In Contract A -1 AT THE SITE AND ALL INCONSISTENCIES SHALL BE BROUGHT TO 12-03-2025 Control Joint SITE MAP NO or #Num Ceiling THE ATTENTION OF THE DEVELOPER AND THE DESIGNER BEFORE CLD. NOM Center Line SHEET SCHEDULE Not To Scale PROCEEDING WITH THE WORK. CMU On Center ANY ERRORS OR OMISSIONS FOUND IN THESE DRAWINGS SHALL COL. Column PTD. Paint, Painted BASEMENT PLAN A - 2 12-03-2025 BE BROUGHT TODEVELOPERS AND DESIGNERS ATTENTION Concrete Pressure Treated INTERIOR EXTERIOR CONT. CW. DBL. Continuous RAD/R IMMEDIATELY. Radius MAPPING AND SURVEYING Cold Wate DO NOT SCALE DRAWINGS. WRITTEN DIMENSIONS TAKE Double 18 SPENCER BROOKLYN REQ Required FIRST FLOOR PLAN 12-03-2025 Diameter A - 3 PRECEDENCE OVER SCALED DIMENSIONS. R.O. Rough Opening **NEW YORK 11211** Down Downspout SIM. SPEC ALL DIMENSIONS ARE TO FACE OF STUD OR TO FACE OF FRAMING DS (929) 486-9091 Specification UNLESS OTHERWISE NOTED. Square Feet propicny.com ALL TRUSS DRAWINGS TO BE REVIEWED AND APPROVED BY THE DWG Drawing SECOND FLOOR PLAN 12-03-2025 A - 4 6. ELEC Electric, Electrical PROPICNY@GMAIL.COM STRUCTURAL ENGINEER PRIOR TO ISSUANCE OF BUILDING STD Standard Elevation PERMIT. Electrical Panel STOR. Storage Top of Plate EQ. Equp ALL OR EQUAL SUBSTITUTIONS MUST BE SUBMITTED TO AND A - 5 ROOF DECK PLAN 12-03-2025 Equipment Each Way ARCHITECTURAL AS-BUILT APPROVED BY CITY BUILDING OFFICIAL PRIOR TO INSTALLATION. TYP. U.O.N. E.W. Unless Noted ALL ELECTRICAL AND MECHANICAL EQUIPMENT AND METERS Existing Otherwise **FORDHAM** Fire Alarm Foundation ARE SUBJECT TO RELOCATION DUE TO FIELD CONDITIONS. FRONT ELEVATION VERT. A - 6 12-03-2025 LEFT - SIDE ELEVATION Walk-in Closes CONTRACTOR TO VERIFY. W.I.C. FIN. FIN. FL Finish WC W/ WD. DAMP PROOFING - ONE GOAT CONTINUOUS ELECTROMETRIC Water Closel Finish Floor With Wood FL, FLR WATERPROOFING FROM GRADE LEVEL TO BOTTOM OF Floor RIGHT - SIDE ELEVATION A - 7 FT FTG Foot or Feet 12-03-2025 FOUNDATION REAR FI EVATION ROAD Footing Flashing SHOP DRAWING REVIEW AND DISTRIBUTION, ALONG WITH FLASH PRODUCT SUBMITTALS, REQUESTED IN THE CONSTRUCTION G.A. GALV Gauge Galvinized DOOR SCHEDULE 12-03-2025 DOCUMENTS, SHALL BE THE SOLE RESPONSIBILITY OF THE WINDOW SCHEDULE Ground Fault GENERAL CONTRACTOR, UNLESS DIRECTED OTHERWISE UNDER Circuit Interrunte GWR Gypsum Wall Board A SEPARATE AGREEMENT. Hose Bibb Hardwood Flooring DEVIATIONS FROM THESE DOCUMENTS IN THE CONSTRUCTION PHASE SHALL BEREVIEWED BY THE DESIGNER AND THE OWNER HGT Head Height PRIOR TO THE START OF WORK IN QUESTION. ANY DEVIATIONS H.H. HORIZ. Horizontal FROM THESE DOCUMENTS WITHOUT PRIOR REVIEW, SHALL BE Hot Water Heate THE SOLE R ESPONSIBILITY OF THE GENERAL CONTRACTOR. INSU Insulation THE GENERAL CONTRACTOR SHALL BE RESPONSIBLE FOR ALL WORK ANDMATERIALS REPRESENTED ON THESE DOCUMENTS INCLUDING THE WORK AND MATERIALS FURNISHED BY SUBCONTRACTORS AND VENDORS. LOCATION MAP: SITE MAP: THE BUILDER SHALL FURNISH ART AND ALL REPORTS RECEIVED FROM THE GEOTECHNICAL ENGINEER (SOILS REPORT), ON THE STUDY OF THE PROPOSED SITE, TO THE DESIGNER, STRUCTURAL ARCHITECT/ENGINEER ENGINEER, AND GENERAL CONTRACTOR, IN THE EVENT THE PARKSIDE HOUSING PROJECT GEOTECHNICAL REPORTS DO NOT EXIST, THE SOILS CONDITION SHALL BE ASSUMED TO BE A MINIMUM DESIGN SOIL PRESSURE STATED BY THE STRUCTURAL ENGINEER OF RECORD FOR THE PURPOSE OF STRUCTURAL DESIGN. GENERAL CONTRACTOR SHALL ASSURE THE SOIL CONDITIONS MEET OR EXCEED THE CRITERIA ALL WORK PERFORMED BY THE GENERAL CONTRACTOR SHALL COMPLY AND CONFORM WITH LOCAL AND STATE BUILDING CODES, ORDINANCES AND REGULATIONS, ALONG WITH ALL OTHER AUTHORITIES HAVING JURISDICTION. THE GENERAL CONTRACTOR IS RESPONSIBLE TO BE AWARE OF THESE GENERAL NOTES REQUIREMENTS AND GOVERNING REGULATIONS. BBREVIATIONS WINDOW SUPPLIER TO VERIFY AT LEAST ONE WINDOW IN ALL SITE MAP LOCATION MAP BEDROOMS TO HAVE A CLEAR EGRESS OPENING OF 5.7 SQ FT SHEET NUMBER WITH MIN. DIMENSION OF 24" IN HEIGHT AND 20" IN WIDTH: A-1 CHECKED: 08



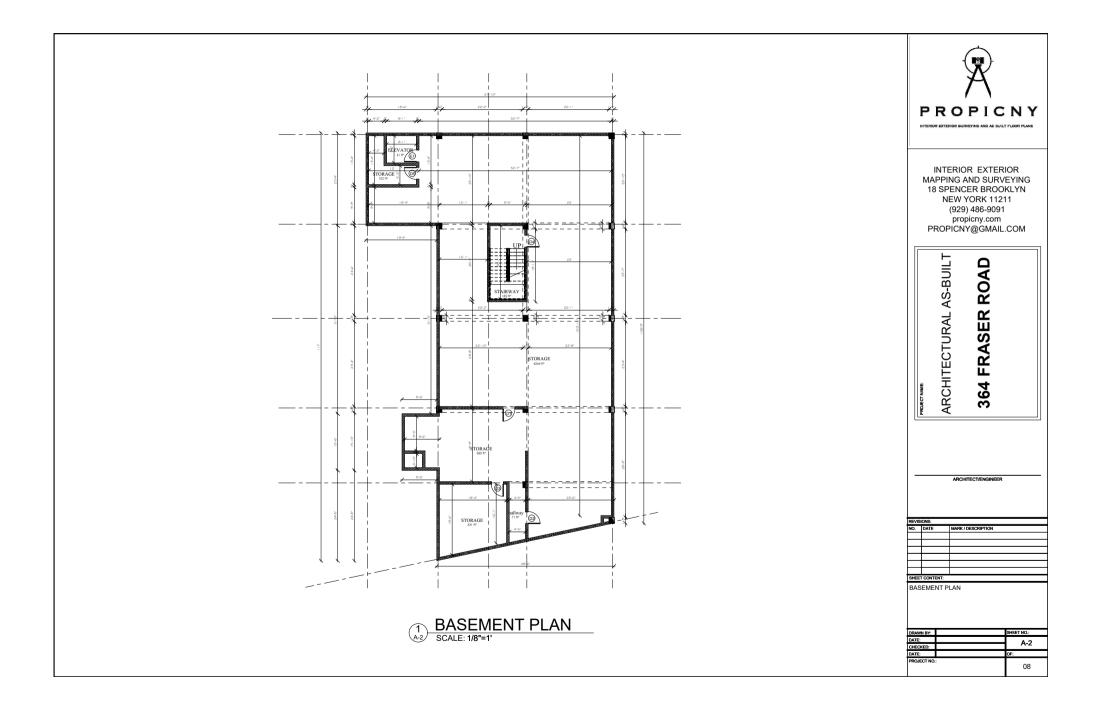



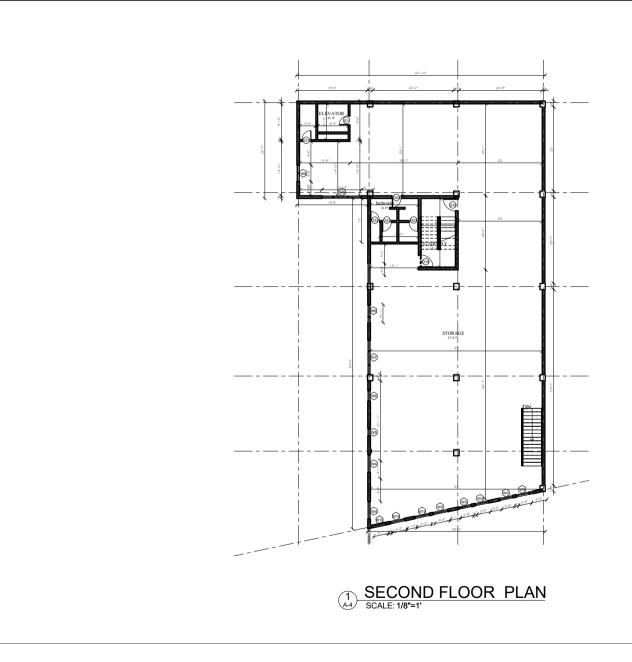

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ARCHITECTURAL AS-BUILT
364 FRASER ROAD

ARCHITECT/ENGINEER


REVISIONS:

NO. DATE MARK / DESCRIPTION

SHEET CONTENT:

SECOND FLOOR PLAN

SHEET NO.: A-4
A-4
A-4
OF:
08

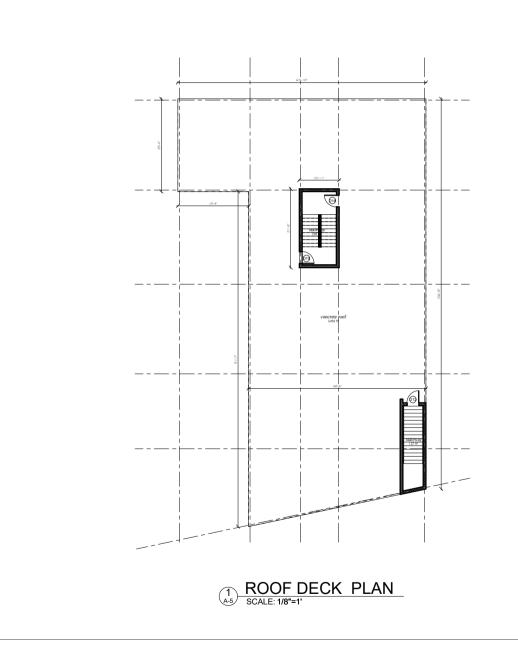



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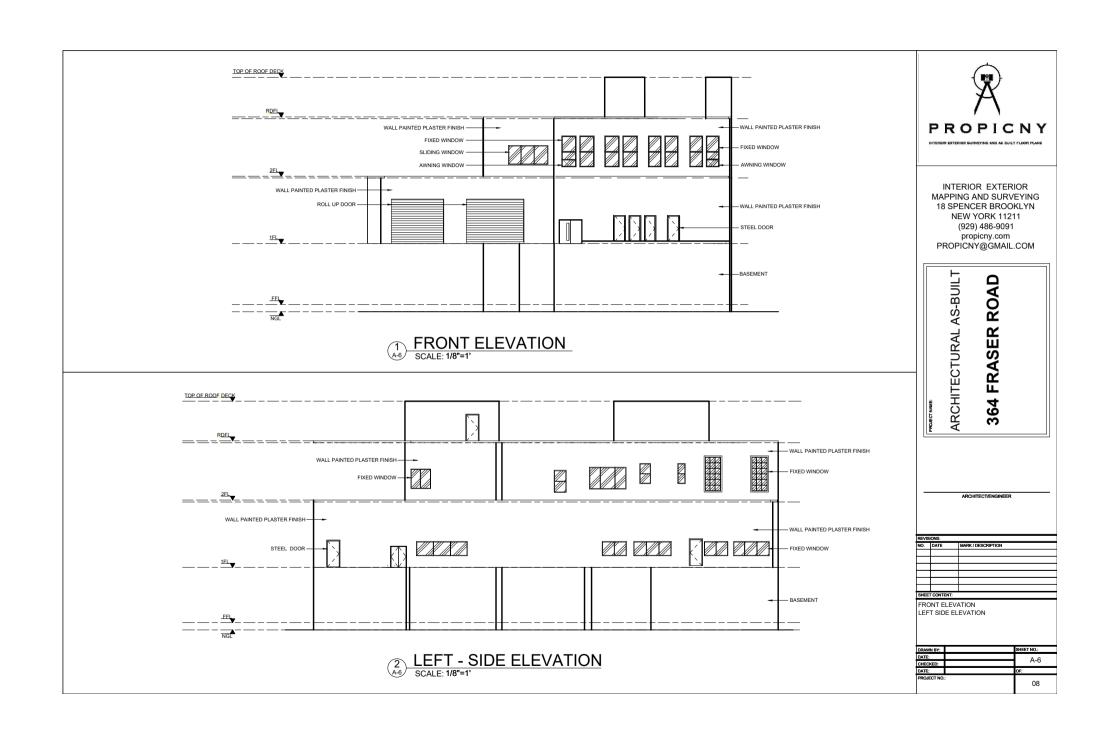
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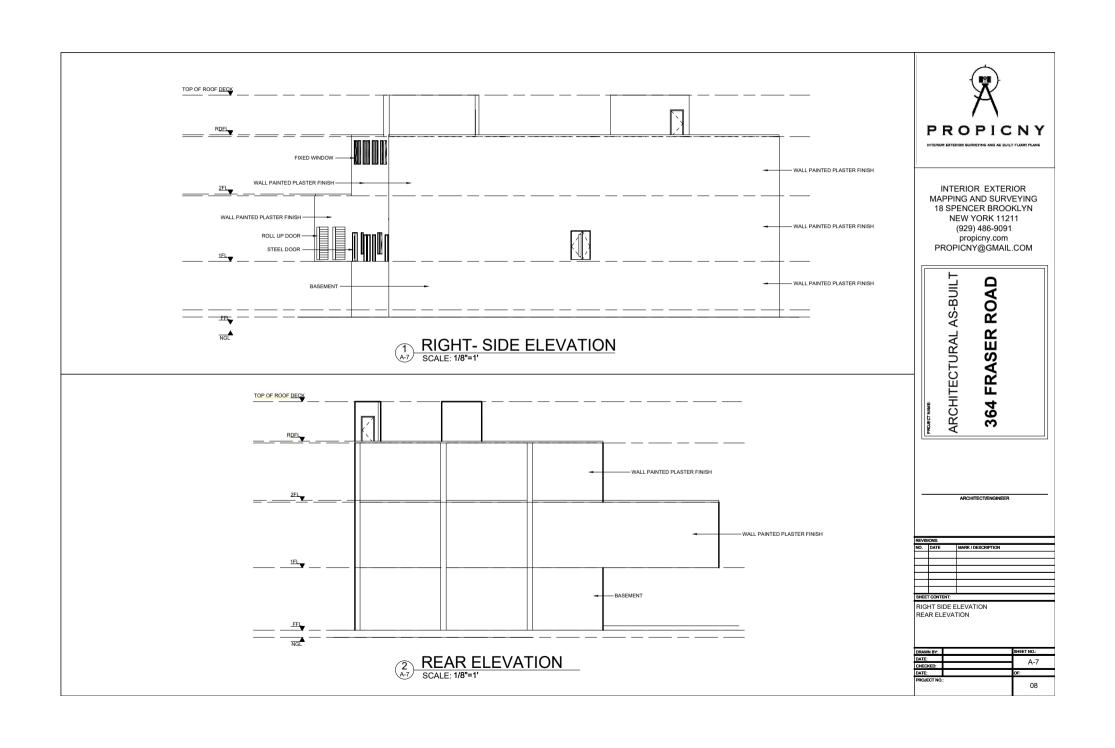
NO. DATE MARK/DESCRIPTION

SHEET CONTENT:

ROOF DECK PLAN

1	DRAWN BY:		SHEET NO.:
	DATE:		A-5
	CHECKED:		A-3
	DATE:		OF:
	PROJECT NO.	:	08





DOOR SCHEDULE			
MARK	WIDTH	HEIGHT	LEVEL
D1	4'-4"	6'-10"	BASEMENT
D2	3'-10"	7'-5"	BASEMENT
D3	3'-3"	6'-11"	BASEMENT
D4	3'-4"	7'-2"	BASEMENT
D5	3'-2"	6'-9"	BASEMENT
R1	14'-8"	12'-1"	BASEMENT
R2	16'-5"	12'-1"	BASEMENT
D7	4'-2"	9'-1"	1ST FLOOR
D8	3'-2"	6'-6"	1ST FLOOR
D9	3'-0"	6'-8"	1ST FLOOR
D10	5'-0"	7'-0"	1ST FLOOR
D11	3'-0"	6'-8"	1ST FLOOR
D12	2'-10"	6'-5"	1ST FLOOR
D13	3'-3"	6'-10"	1ST FLOOR
D14	6'-3"	6'-8"	1ST FLOOR
D15	3'-1"	7'-0"	1ST FLOOR
D16	3'-2"	6'-11"	1ST FLOOR
D17	4'-2"	5'-8"	1ST FLOOR
D18	3'-4"	5'-4"	1ST FLOOR
D19	3'-3"	6'-3"	2ND FLOOR
D20	3'-6"	7'-0"	2ND FLOOR
D21	3'-2"	6'-9"	2ND FLOOR
D22	3'-1"	6'-10"	2ND FLOOR
D23	2'-4"	6'-10"	2ND FLOOR
E1	3'-7"	7'-2"	ELEVATOR

WINDOW SCHEDULE				
MARK	WIDTH	HEIGHT	LEVEL	
W1	10'-3"	3'-11"	1ST FLOOR	
W2	6'-5"	3'-11"	1ST FLOOR	
W3	3'-8"	6'-8"	2ND FLOOR	
W4	4'-11"	9'-11"	2ND FLOOR	
W5	2'-1"	5'-6"	2ND FLOOR	
W6	3'-0"	5'-6"	2ND FLOOR	
W7	10'-1"	6'-0"	2ND FLOOR	
W8	5'-5"	5'-5"	2ND FLOOR	
W9	10'-10"	5'-2"	2ND FLOOR	
W10	4'-2"	6'-8"	2ND FLOOR	



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364 FRASER ROAD

ARCHITECT/ENGINEER

REVIS	SIONS:	
NO.	MARK / DESCRIPTION	
SHEE	T CONTENT:	
DO	OR SCHE	DULE
WINDOW SCHEDULE		
1		

DRAWN BY:		SHEET NO.:	
DATE:		A-8	
CHECKED:		A-0	
DATE:		OF:	
PROJECT NO.	:	08	

DOOR SCHEDULE

SCALE: N.T.S.

WINDOW SCHEDULE SCALE: N.T.S.